

CHARLOTTE HISTORIC DISTRICT COMMISSION

CERTIFICATE OF APPROPRIATENESS - Amended

CERTIFICATE NUMBER: 2017-00417 DATE: January 10, 2018

March 20, 2018 – AMENDED June 22, 2018 – AMENDED

ADDRESS OF PROPERTY: 901 East Worthington Avenue **TAX PARCEL NUMBER:** 12108101

HISTORIC DISTRICT: Dilworth

APPLICANT/OWNER: John Fryday/Nick Zalecki

DETAILS OF APPROVED PROJECT: The project is the construction of a single family house and detached garage. The proposed front setback is 30 feet from the right of way to the front porch. Front porch depth is 8 feet. Side and rear yards setbacks are noted on the site plan. Total height is +/-29'-4". Materials include wood lap siding with mitered corners, wood shake siding in the dormers, and brick foundation and porch piers. Windows are wood Simulated True Divided Light (STDL), window sizes and trim are noted on the detail plan sheets. The detached garage materials and details match the house, the height is +/- 22'. Garage height cannot exceed 24 feet. Access to the detached garage is from the alley easement from Park Road. New trees will be planted to replace those removed. The project was approved by the HDC October 11, 2017. See attached amended plans.

- > This Certificate of Appropriateness (COA) indicates that this project proposal has been determined to comply with the standards and policies of the Charlotte Historic District Commission.
- Display the blue COA placard in a visible location along with any required permits.
- No other approvals are to be inferred.
- No demolition other than that specifically indicated on any attached plans is authorized under this approval.
- > All work must be completed in accordance with all other applicable state and local codes.
- Any changes from or additions or deletions to the plans referenced herein will void this Certificate, and a new application must be filed with the Historic District Commission.

This Certificate is valid for a period of twelve (12) months from the date of issuance. Failure to obtain a building permit in that time will be considered as a failure to comply with the Certificate and the Certificate will become invalid. If a building permit is not required, then the approved work must be completed within twelve (12) months of the date of issuance of this Certificate. In either situation, the Certificate can be renewed for an additional twelve (12) months by Historic District Commission staff by written request within the first twelve (12) months from the date of issuance.


Chairman

CHARLOTTE-MECKLENBURG PLANNING DEPARTMENT

taff John C.

www.charlotteplanning.org

600 East Fourth Street Charlotte, NC 28202-2853 PH: (704)-336-2205 FAX: (704)-336-5123

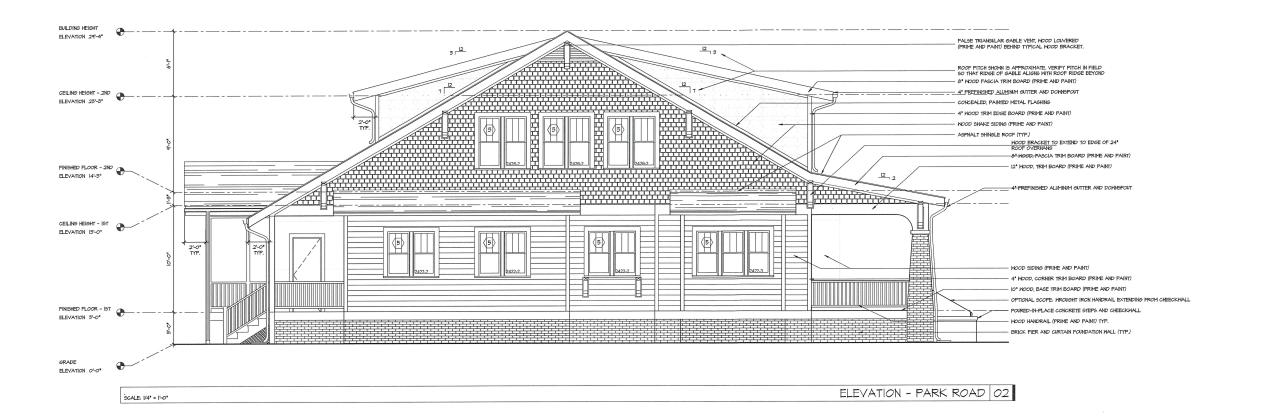

Note: Lap siding will have mitered corners instead of cornerboards on both the house and garage.















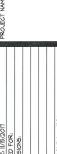



A5.1



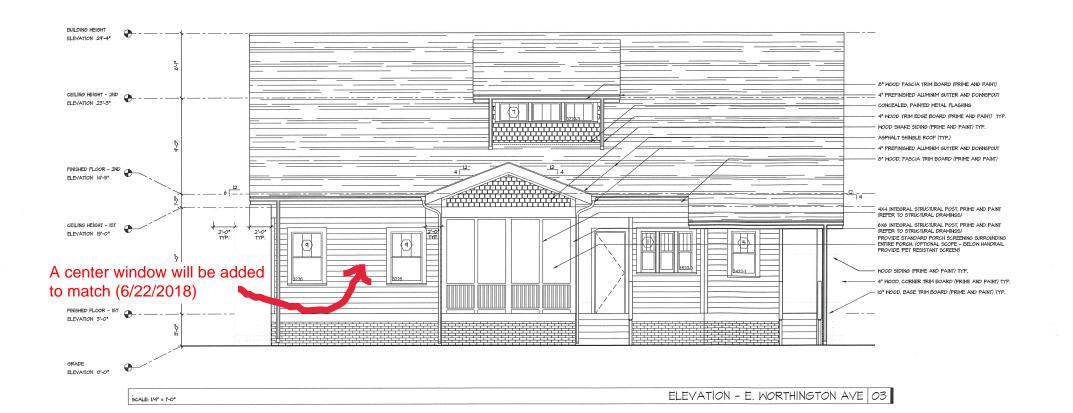













ZALECKI PROPERTY 901 E. MORTHINGTON AVENJE CHARLOTTE, NC. 28203



ELEVATIONS


SHEET NUMBER: A5.2

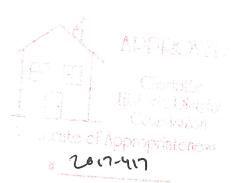

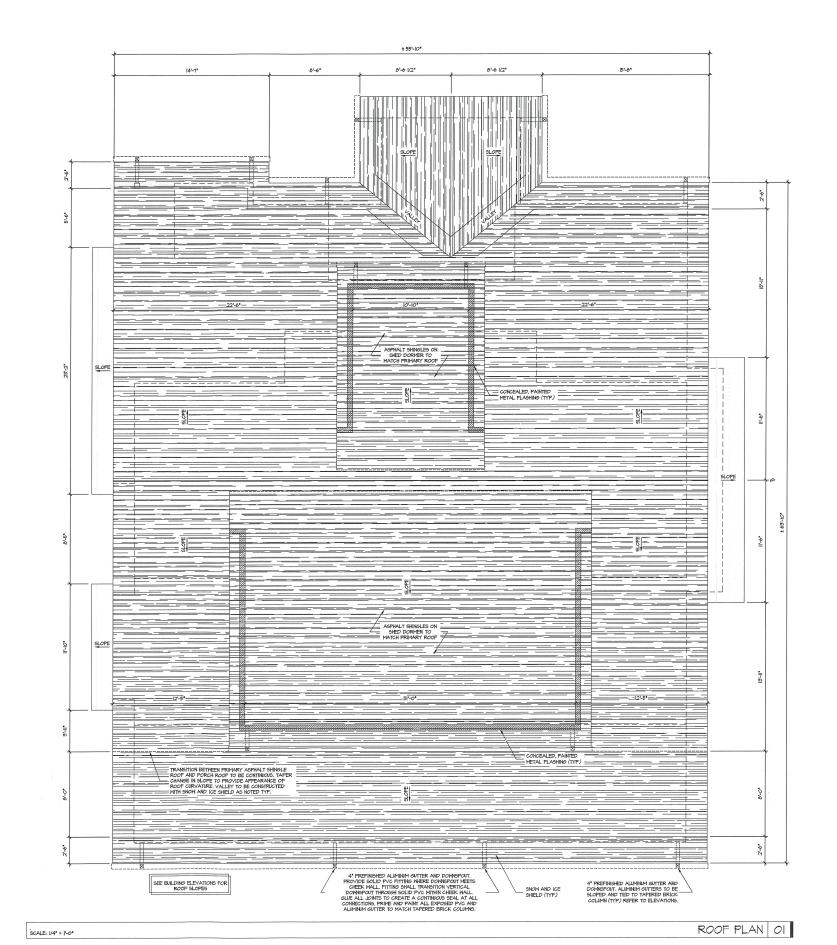





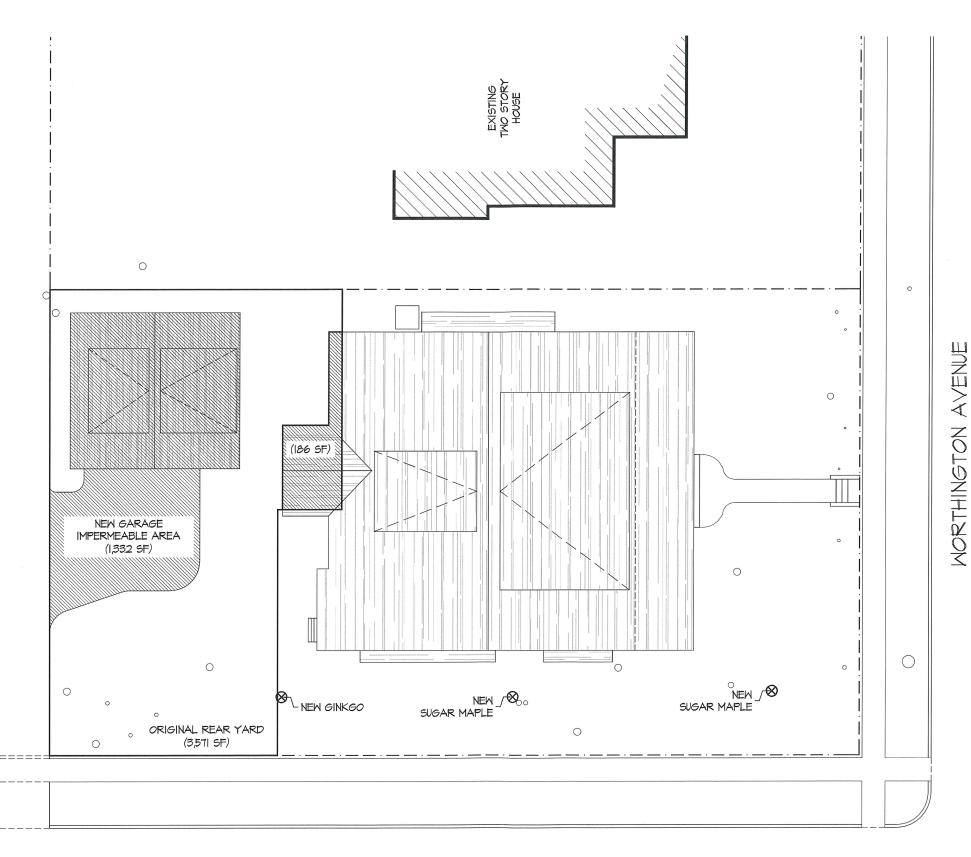

TOTAL PERMEABILITY CALCULATION =

1,518 SF / 3,571 SF = 43% IMPERMEABLE SURFACE

PARK ROAD

FRYDAY

& DOYNE

ABGHIPH STUDEN

118 East Kingston Avenue
Suite 20
Charlotte, NC 28203

Tel: 704-372-0001 Fax: 704-372-2517 www.fryday-doyne.com

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@FRYDAY & DOYNE

PROJECT NAME:

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ISSUED FOR:

HDC REVIEW

SMG


REVISIONS:

SHEET TITLE:

DRAWN BY:

SHEET NUMBER:

HDC-21

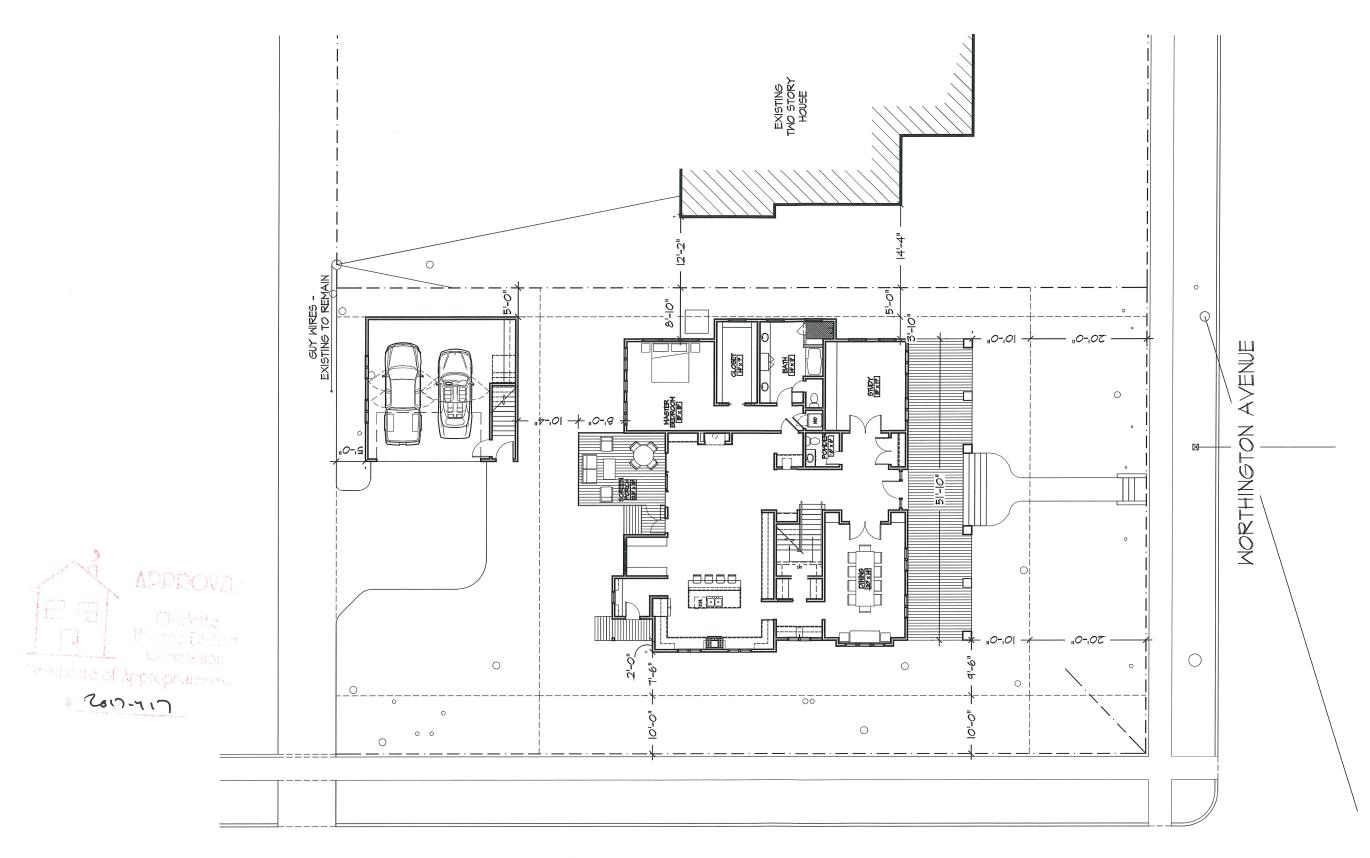

PARK ROAD

SITE SURVEY - PROPOSED SITE PLAN | OI

FRYDAY & DOYNE ARGRITATOURS . INTERIOR DESIGN

118 East Kingston Avenue Suite 20 Charlotte, NC 28203

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PROJECT NAME:

ZALECKI PROPERTY 901 E. WORTHINGTON AVE CHARLOTTE, NC 28203

DATE: 10-02-2017

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REVISIONS:

DRAWN BY:


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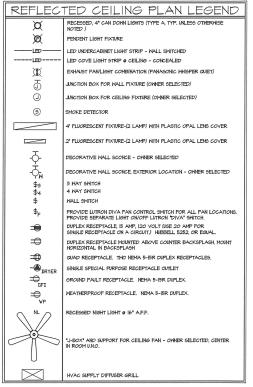
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HDC-10



マロハー417



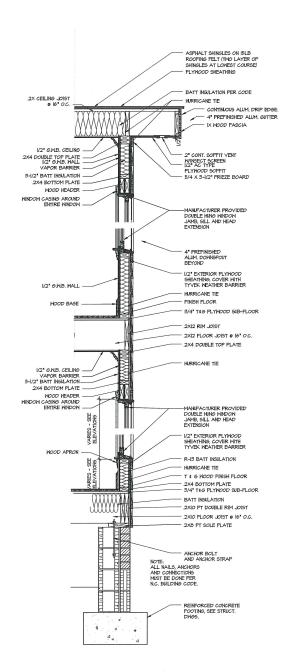

NOTES:

I. ALL NEW LIGHT CIRCUITS TO BE ON DIMMERS. (DIMMER-CONTINUOUS TOSSILE OR TOSSILE W SLIDE DIMMER) $\,$

- 3. GANG SWITCHES TOGETHER AS MUCH AS POSSIBLE.
- 4. REVIEW ALL SWITCH AND OUTLET LOCATIONS WITH OWNER DURING ROUGH IN.
- 5. ALL RECESSED CEILING FIXTURES ARE TO BE TYPE A UNLESS OTHERWISE INDICATED.
- $\theta.$ ALL LIGHTS SHALL BE ON LUTRON DIVA DIMMERS. LOCATIONS OF SWITCHES SHALL BE AS DETERMINED BY THE OWNER.
- 7. ALL CEILINGS SHALL BE I/2 INCH THICK GYPSUM WALLBOARD. CEILING WALLBOARD SHALL BE SCREWED IN AT NOT MORE THAN θ INCHES ON CENTER.
- 8. PRIME AND PAINT ALL CEILINGS.

GENERAL NOTES ALL FOUNDATION DIMENSIONS ARE TO THE FACE OF BLOCK. 2. PORCH FOUNDATION TO BE PIER AND CURTAIN. 3. FACE OF STUD TO ALIGN HITH FACE OF BRICK UND. 1. PACKED OF STUD TO ALIGN HITH FACE OF BRICK UND. 1. PACKED OF STUD TO ALIGN HITH FACE OF BRICK UND. 1. PACKED OF STUD OF STUD

DOC	OR SCHEDULE	
\triangle	68" X 8'-0"	2 PANEL SLIDING GLASS POCKETING DOOR, EXTERI
B	36" x 8'-0"	OWNER SELECTED EXTERIOR DOOR UNIT
0	56" X T'-0"	OWNER SELECTED EXTERIO DOOR
D	36" X T'-0"	3 PANEL INTERIOR DOOR
E	32" X T'-0"	3 PANEL INTERIOR DOOR
F	28' X T'-0'	3 PANEL INTERIOR DOOR
6	28" X 3'-6"	INTERIOR ATTIC DOOR
\oplus	24" X 7'-0"	3 PANEL INTERIOR DOOR
J	36" X 7'-0"	INTERIOR POCKET DOOR
(K)	(2) 18" X T'-0"	PAIRED POCKET DOOR


I. ALL INTERIOR DOORS SHALL BE PAINT GRADE MDF


- I. ALL INTERIOR DOORS SHALL BE PAINT GRADE MOP DOORS, PRIME AND PAINT.

 2. EXTERIOR DOORS TO RECEIVE ONE COAT OF FINIER THO COATS OF PLAYED BAHALL CLOR SELECTED BY ONNER. UND.


 3. INTERIOR DOORS TO BE PAINTED WITH ONE COAT FRIMER, THO COATS LATEX SEMI-6-LOSS, COLOR SELECTED BY ONNER. UND.


 4. TEMPERED SALLS IS TO BE INSTALLED FER NORTH CANCULAR RESIDENTIAL BUILDING CODE IN ANY DOOR NEWLATE TO RESIDENTIAL BUILDING CODE IN ANY DOOR NEWLATE TO RESIDENTIAL BUILDING RESIDENTIAL BUILDING CODE IN ANY DOOR NEWLATE TO RESIDENTIAL BUILDING CODE.

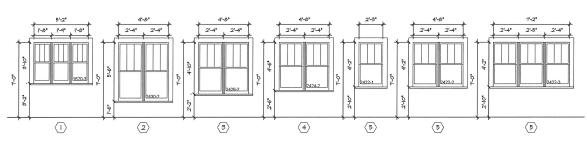


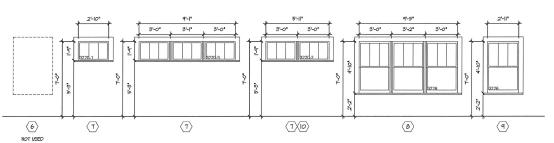

WINDOW SCHEDULE 05 . SCALE: I/4" = I'-0"

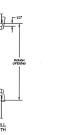

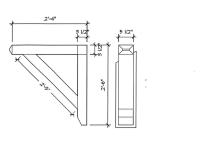

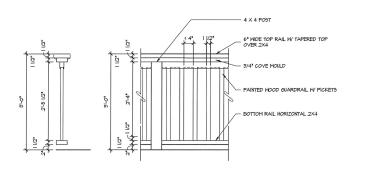











ZALECKI PROPERTY N.E. WORTHINGTON AYENJI CHARLOTTE, NC 28203







SHEET NUMBER: A4.I





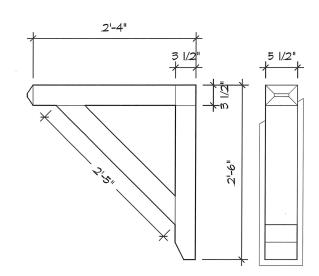

BRACKET DETAIL SCALE: 3/4" = 1'-0"

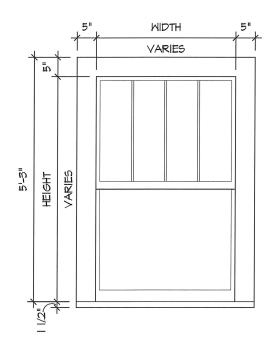

SCALE: 1/2" = 1'-0"

WINDOW DETAIL

ZALECKI PROPERTY 401 E. WORTHINGTON AVE CHARLOTTE, NC. 28203

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PROJECT NAME:

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REVISIONS:

DRAWN BY:

SHEET TITLE:

SHEET NUMBER:

HDC-24

6" WIDE TOP RAIL W/ TAPERED TOP OVER 2X4 - 3/4" COVE MOULD PAINTED WOOD GUARDRAIL W/ PICKETS BOTTOM RAIL 2X3 OVER HORIZONTAL 2X4

E. WORTHINGTON AVENUE ELEVATION 02

SCALE: 3/4" = 1'-0"

GUARDRAIL

SCALE: 1/4" = 1'-0"

2017-417

CROWN: SPIEGEL WOODWORKING SAW 327 3/4" TRIM BOARD WITH 3/16" BEADED EDGE ASPHALT SHINGLE ROOF

GUTTERS AND DOWNSPOUTS:

WOOD SOFFIT TO MATCH BEAD BOARD CEILING IN FINISH COLOR CONTINUOUS WOOD BEAMS WITH VERTICAL TIES TO BRICK COLUMNS. WOOD BEAM TO BE CLAD WITH PAINTED WOOD TRIM CONCRETE CAP ABOVE TAPERED COLUMN

TAPERED BRICK COLUMN, TAPERING TO END AT PORCH LEVEL

34" PAINTED WOOD GUARDRAIL WITH 1/4" PICKETS 34" WROUGHT IRON HANDRAIL TIED TO CHEEK WALL AND COLUMN FACE


CAST-IN-PLACE CONCRETE STEPS TO MEET PORCH FRONT

CONCRETE CAP ABOVE BRICK CHEEK WALL

WOOD T&G PORCH FLOOR - SLOPE TO FRONT EDGE

BRICK FOUNDATION WITH CMU BLOCK BACKING. PAINTED WOOD SKIRT BOARD AND WOOD TRIM AT PORCH EDGE.



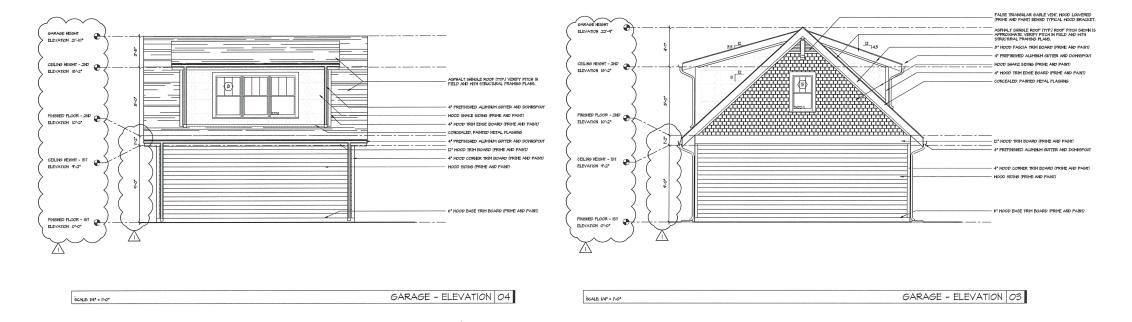

CERT. NO. 50879

A6.2

